


VAV BOX HOT WATER


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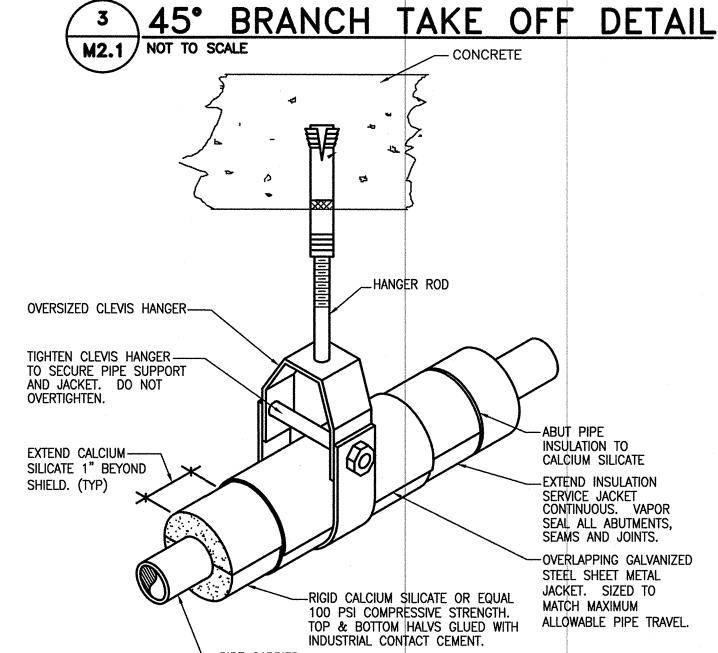
VAV BOX HOT WATER

To Scale

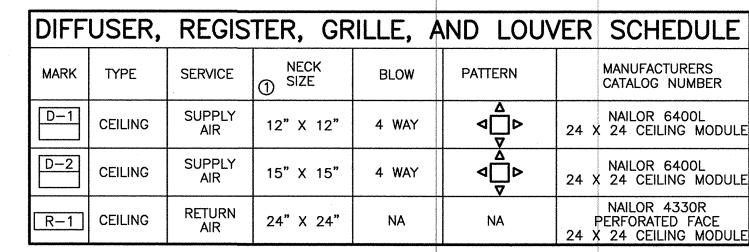


1 WALL GRILLES, REGISTERS AND LOUVERS DIMENSIONS LIST THE HORIZONTAL DIMENSION FIRST.



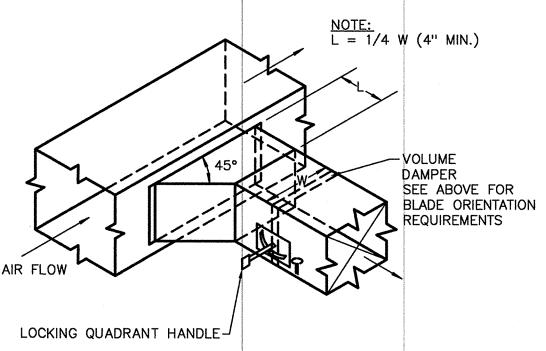

6 PIPE SUPPORT DETAIL
NOT TO SCALE

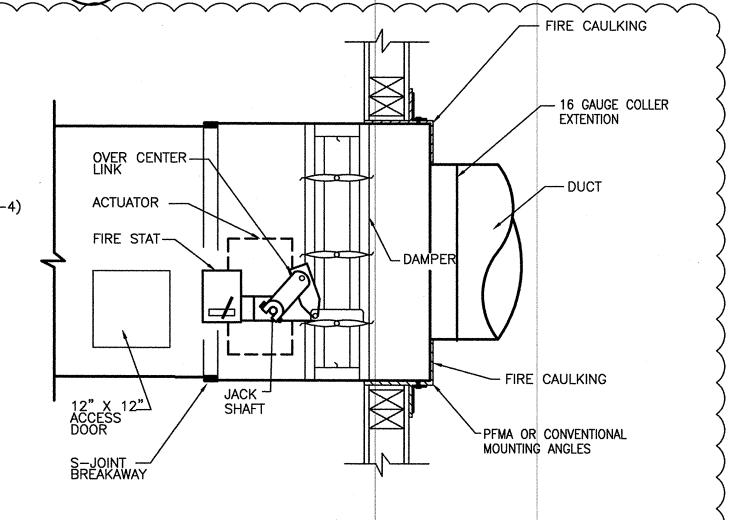

COMBINATION

FIRE (SMOKE DA

FIRE/SMOKE DAMPER DETAIL

NOT TO SCALE



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SOCIAL SCIENCE BUILDING
3RD FLOOR REMODEL

WSU: JIM HARRIS CAMPUS DEVELOPMENT 2601 UNIVERSITY CIRCLE OGDEN, UT 84408-2601

DFCM: TIM PARKINSON DFCM PROJECT #08319810

DATE: MARCH 02, 2009

PROJECT NO: CRSA B08-033


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DRAWN BY:

CHECKED BY: ceh/drs

MECHANICAL DETAILS

M201 SHEET 3 OF 3

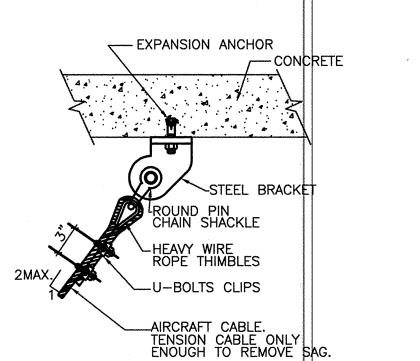

UPPER ATTACHMENT
TO CONCRETE

M2.1 NOT TO SCALE

EQUIPMENT

SEISMIC RESTRAINT DETAIL

NOT TO SCALE


EQUIPMENT CONNECTION (ATTACH AT 4 CORNERS)

-2" X 3" X 1/8" (BENT STEEL PLATE)

-TERMINAL BOX

3/8"ø THRU BOLT ATTACH TO EQUIPMENT STRUCTURAL SUPPORT POINT


CLEVIS -

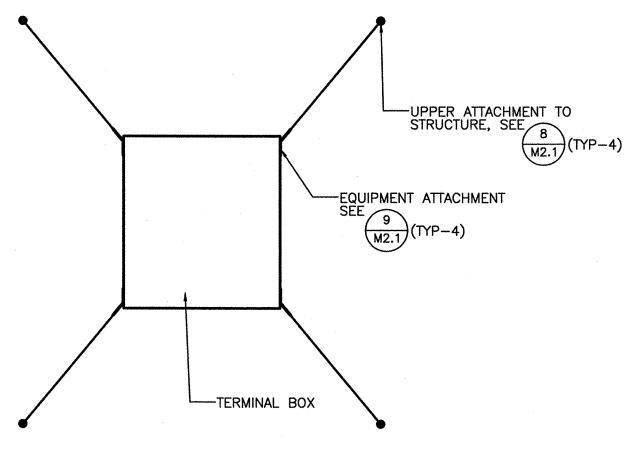



EQUIPMENT

SEISMIC RESTRAINT DETAIL


NOT TO SCALE

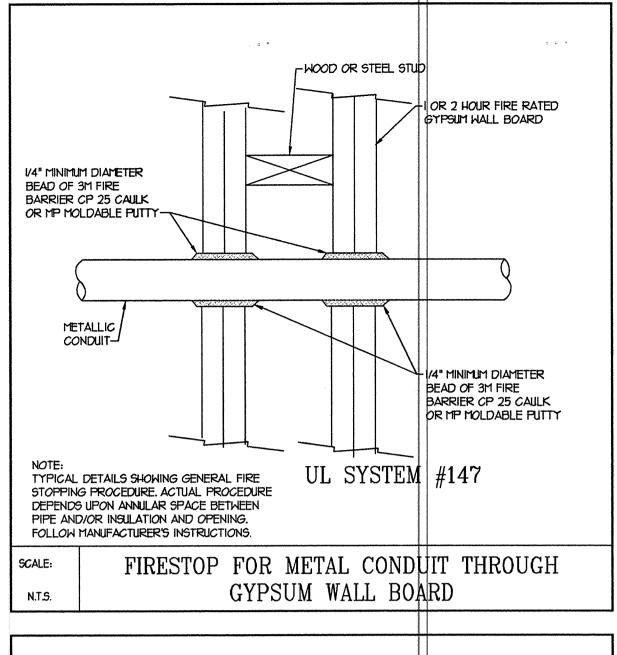

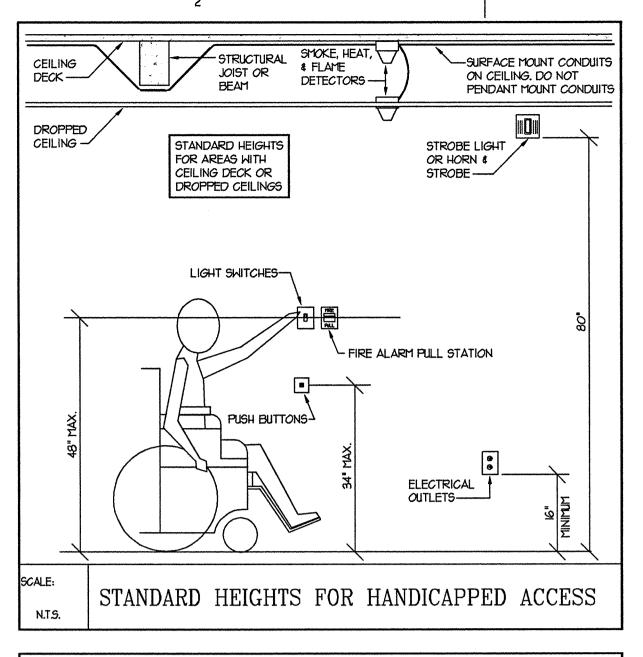

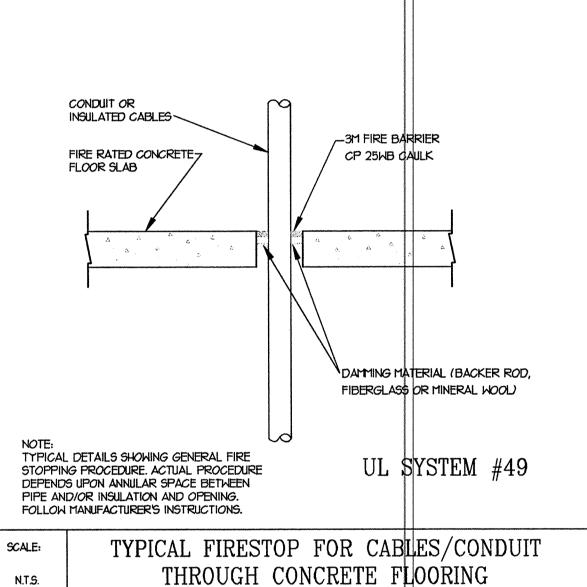



N.T.S.

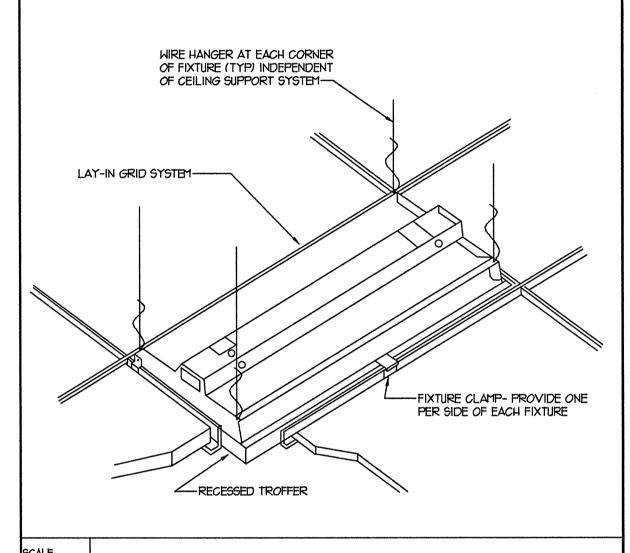

TYPICAL RECESSED FIXTURE MOUNTING DETAIL

N.T.S.

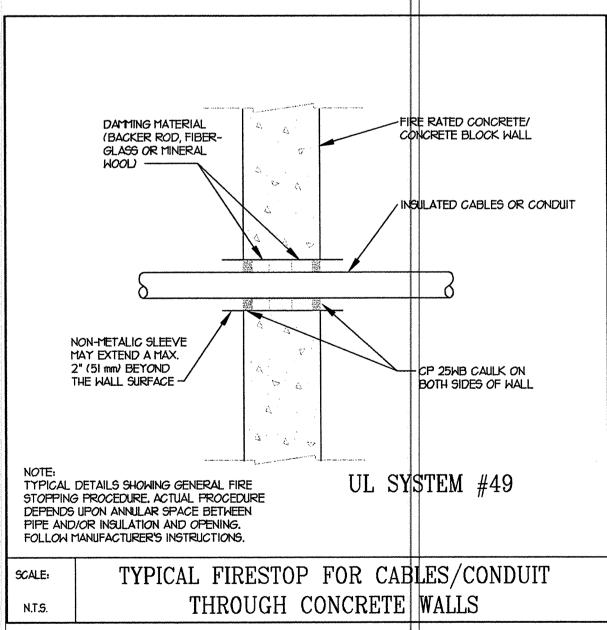

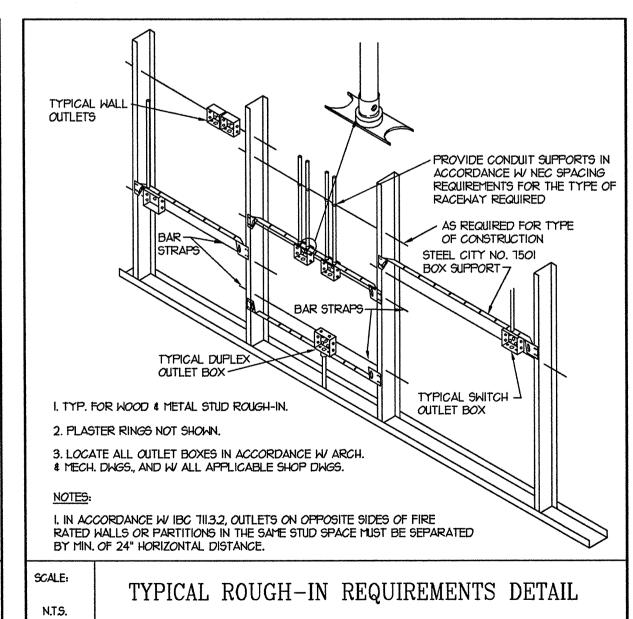

SYMBOL	DESCRIPTION				
	RECESSED FLUORESCENT FIXTURE				
LJE	FIXTURES ON EMERGENCY POWER				
$\boxtimes$	EXIT LIGHT. ARROWS SHOW EXIT DIRECTION				
\$a,b	SINGLE POLE TOGGLE SWITCH - 20 AMP, LETTERS INDICATE SWITCH ASSIGNMENT				
(T-X)	LIGHTING FIXTURE CALLOUT. NUMBER INDICATES A SUGGESTED QUANTITY- TO BE VERIFIED				
$\otimes_{\!$	REFERENCE NOTE CALLOUT				
POWER SYSTEMS SYMBOL LIST					
SYMBOL	DESCRIPTION				
Ф	DUPLEX CONVENIENCE OUTLET - 20 AMP				
(1)	DUPLEX CONVENIENCE OUTLER - 20 AMP GROUND FAULT INTERRUPTER				
⊙∢	FLUSH FLOOR POKE THROUGH OUTLET WITH DATA				
<u> </u>	JUNCTION BOX - SIZE AND FUNCTION AS REQUIRED				
<b>③</b>	MOTOR LOCATION				
	MANUAL DISCONNECT WITH THERMAL OVERLOAD PROTECTION				
\$ <del>1</del>	MANUAL DISCONNECT WITH THERMAL OVERLOAD PROTECTION				
\$1 [2][2][2]	MANUAL DISCONNECT WITH THERMAL OVERLOAD PROTECTION  ELECTRICAL PANEL LOCATION				
	ELECTRICAL PANEL LOCATION				
77772	ELECTRICAL PANEL LOCATION  COMMUNICATION SYSTEMS SYMBOL LIST				
77772	ELECTRICAL PANEL LOCATION  COMMUNICATION SYSTEMS SYMBOL LIST  DESCRIPTION				
SYMBOL	ELECTRICAL PANEL LOCATION  COMMUNICATION SYSTEMS SYMBOL LIST  DESCRIPTION  FLUSH DATA/TELEPHONE OUTLET				
SYMBOL  SYMBOL	ELECTRICAL PANEL LOCATION  COMMUNICATION SYSTEMS SYMBOL LIST  DESCRIPTION  FLUSH DATA/TELEPHONE OUTLET  SOUND SYSTEM SPEAKER, W=WALL MOUNTED				
SYMBOL  SYMBOL	ELECTRICAL PANEL LOCATION  COMMUNICATION SYSTEMS SYMBOL LIST  DESCRIPTION  FLUSH DATA/TELEPHONE OUTLET  SOUND SYSTEM SPEAKER, W=WALL MOUNTED  CLOCK OUTLET				
SYMBOL  S C	ELECTRICAL PANEL LOCATION  COMMUNICATION SYSTEMS SYMBOL LIST  DESCRIPTION  FLUSH DATA/TELEPHONE OUTLET  SOUND SYSTEM SPEAKER, W=WALL MOUNTED  CLOCK OUTLET  FIRE ALARM SYSTEM SYMBOL LIST				
SYMBOL  SYMBOL  SYMBOL	ELECTRICAL PANEL LOCATION  COMMUNICATION SYSTEMS SYMBOL LIST  DESCRIPTION  FLUSH DATA/TELEPHONE OUTLET  SOUND SYSTEM SPEAKER, W=WALL MOUNTED  CLOCK OUTLET  FIRE ALARM SYSTEM SYMBOL LIST  DESCRIPTION				
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LIGHTING SYSTEM SYMBOL LIST

LIGHTING FIXTURE SCHEDULE						
SYMBOL	DESCRIPTION	LAMP9	APPROVED MANUFACTURERS	CATALOG NUMBER		
	2'X4' LAY-IN FLUORESCENT WITH DIMMING BALLAST.	(2) T-8 28 W	COLUMBIA	ZPT24-228G-FCB9-EPU		
(T-I)			LIGHTOLIER	H952GLR228-UNV-HI		
			LITHONIA	2RT5 28T5 MVOLT GEBIOPS LMP84IP		
		'	METALUX	2AC-228T5-UNV-EBTI		
			DAY-BRITE	2ATNG228-D-UNV-1/2-EB95-LPT841		
	6" RECESSED MOUNTED INCANDESCENT LIGHT FIXTURE WITH SELF TRIM REFLECTOR.	75W PAR 30	PRESCOLITE	79X-9T832		
(T-2)			LIGHTOLIER	CP30DCPW W/ C6120		
			LITHONIA	APR PAR 30 6AR		
			PORTFOLIO	HD6-630I-LI		
			LSI	206VIK75WC27206VCL		
	LED EDGE LITE RECESSED HARDWARE EXIT SIGN WITH, GREEN LETTERS AND NICAD BATTERY PACK UNIT.	INCLUDED	DUAL-LITE	LE*9G*E		
			LIGHTOLIER	LEECIGW		
			ISOLITE	ELT-EM-G-IC-BA-XX-XX		
			LITHONIA	LPR W I GW LRA 120/277-EL-N		
			EXITRONIX	903HBGCXXBA		

I. ALL FLUORESCENT LIGHTS SHALL HAVE ELECTRONIC INSTANT START BALLAST'S, 10%, TOTAL HARMONIC DISTORTION AND .18 OR LESS BALLAST FACTOR. UNIVERSAL, ADVANCE AND HOWARD ARE APPROVED MANUFACTURERS. BALLAST'S TO HAVE 5 YEAR WARRANTY.

- 2. ALL FLUORESCENT LAMPS SHALL HAVE 4100° COLOR TEMPERATURE.
- 3. THE WRITTEN CRITERIA OF THE FIXTURE DESCRIPTION TAKES PRECEDENCE OVER THE CATALOG NUMBER.
- 4. PROVIDE PREMIUM T-8 LAMPS AND BALLASTS.

## GENERAL NOTES:

- IN THE EXISTING SPACES TO BE RENOVATED, THE CONTRACTOR SHALL REMOVE ALL LIGHT FIXTURES, SWITCHES, WIRING, CONDUIT, WIRING DEVICES, SPEAKERS, VOLUME CONTROLS, ETC. AS REQUIRED WHETHER OR NOT SHOWN ON THE DRAWINGS.
- ALL MATERIALS TO BE REMOVED AND RETURNED TO THE OWNER. MATERIALS WHICH THE OWNER DECIDES NOT TO KEEP SHALL BE SALVAGED AND REMOVED FROM THE SITE BY THE CONTRACTOR.
- ALL CONCEALED CONDUIT THAT CANNOT BE REMOVED SHALL BE CUT FLUSH WITH THE FINISH SURFACES AND CAPPED OFF AFTER THE WIRING HAS BEEN DISCONNECTED AT THE PANEL AND REMOVED FROM THE CONDUIT.
- IN AREAS WHERE CIRCUIT CONTINUITY IS INTERRUPTED, BUT MUST BE MAINTAINED BECAUSE OF THE NATURE OF THE FACILITY, MAKE ALL THE NECESSARY MODIFICATIONS TO THE CIRCUITS IN ORDER TO MAINTAIN THE CIRCUIT INTEGRITY AS QUICKLY AS POSSIBLE.
- THE CONTRACTOR SHALL PATCH THE WALLS AND CEILINGS WHERE THE DEVICES ARE REMOVED TO MATCH THE EXISTING WALLS AND CEILINGS. COORDINATE WITH THE GENERAL CONTRACTOR.
- THE COLOR OF ALL THE NEW DEVICES AND COVERPLATES SHALL MATCH THE COLOR OF THE EXISTING DEVICES AND COVERPLATES.
- REFER TO THE ARCHITECTURAL REFLECTED CEILING PLANS FOR THE EXACT LOCATION OF ALL LIGHTING FIXTURES.
- ALL NEW CONDUITS AND J-BOXES SHALL BE CONCEALED IN WALLS OR ABOVE CEILINGS. CUT AND PATCH WALLS AS REQUIRED. COORDINATE THIS WORK WITH GENERAL CONTRACTOR.
- MINIMUM SIZE OF CONDUIT TO BE 3/4". ALUMINUM CONDUITS SHALL NOT BE
- USE RIGID STEEL SET SCREW TYPE FITTINGS ONLY. DIE CAST FITTINGS SHALL NOT BE USED.
- SUPPORT THE LAY-IN TYPE FIXTURES FROM THE CEILING DECK INDEPENDENT OF THE CEILING GRID, AS SHOWN ON THE TYPICAL RECESSED FIXTURE MOUNTING DETAIL.
- ALL NEW WORK MUST MEET THE CURRENT ADOPTED NATIONAL ELECTRICAL
- NOT MORE THAN THREE (3) CIRCUITS, SHALL BE INSTALLED IN A CONDUIT. EACH CIRCUIT SHALL CONSIST OF I CONDUCTOR FOR EACH PHASE, I NEUTRAL AND I GROUND, FOR A TOTAL OF FIVE CONDUCTORS.
- THE MINIMUM SIZE OF THE CONDUCTORS ARE TO BE #12 AWG THHN COPPER, UNLESS INDICATED OTHERWISE ON THE DRAWINGS.
- ALL J-BOXES SHALL HAVE MINIMUM DEPTH OF 2-1/8" UNLESS OTHERWISE SPECIFIED. SECURE ALL J-BOXES AS SHOWN IN THE DETAILS. FURNISH AND
- INSTALL PROPER MUD RINGS. ALL NEW EXPOSED CONDUIT MUST RUN AGAINST THE WALLS OR CEILINGS. DO NOT PENDANT MOUNT ANY CONDUIT FROM THE CEILINGS.
- ALL THE HOMERUNS MUST BE ACCESSIBLE IN THE CEILING PLENUM. DO NOT CARRY A HOMERUN FROM ONE DEVICE TO ANOTHER WHICH IS TIED TO A SEPARATE HOMERUN INSIDE THE WALL. MARK ON ALL THE J-BOXES THE CIRCUIT NAMES AND NUMBERS. USE NO. 10 THHN CONDUCTORS FOR CONDUCTOR LENGTH OVER 100 FEET, NO. 8 THHN OVER 200 FEET, NO. 6 THHN OVER 300 FEET AND NO. 4 THHN OVER 400 FEET LENGTH.
- PAINT ALL THE J-BOXES FOR FIRE ALARM SYSTEM WITH RED PAINT. USE RED CONDUIT FOR FIRE ALARM SYSTEM.
- COORDINATE WITH THE OWNER AND ARCHITECT FOR THE EXACT LOCATION OF THE OUTLETS.
- LIGHT SWITCHES INSTALLED ADJACENT TO EACH OTHER, SHALL BE GANGED TOGETHER WITH ONE PIECE COVERPLATE.
- AT THE END OF THE JOB, PROVIDE BLANK COVER PLATES TO MATCH THE OTHER COVER PLATES FOR ALL J-BOXES WHERE DEVICES HAVE NOT YET
- SEAL AROUND ALL CONDUIT PENETRATIONS THROUGH FIRE RATED WALLS AND CEILINGS WITH FIRE RATED MATERIAL. 3M IS AN APPROVED MANUFACTURER.
- ALL ELECTRICAL WIRING MUST BE IN CONDUIT (ROMEX AND MC CABLE NOT

ALL MATERIALS USED IN THIS INSTALLATION SHALL BE U.L. APPROVED AND

- FLEXIBLE CONDUITS CAN ONLY BE USED FOR SHORT RUNS (6' MAXIMUM).
- NO CONDUITS SHALL RUN IN DUCT WORK.
- PRIOR TO SUBMITTING A BID THE ELECTRICAL CONTRACTOR SHALL INSPECT THE SITE AND INCLUDE IN HIS BID PACKAGE ALL CHARGES DUE TO EXISTING CONDITIONS. SHOP DRAWINGS ARE REQUIRED. ALL LABOR, MATERIAL AND WORKMANSHIP SHALL BE GUARANTEED FOR A PERIOD OF I YEAR FROM THE DATE OF ACCEPTANCE BY THE TENANT. REPLACE OR REPAIR ALL DEFECTS DURING THE GUARANTEED PERIOD.
- ALL DUPLEX OUTLETS AND SWITCHES SHALL BE 20 AMP., 120 VOLT SPEC GRADE. HUBBELL AND PASS & SEYMOUR AND LEVITON ARE APPROVED MANUFACTURERS.
- THE CONTRACTOR SHALL INFORM THE ARCHITECT/ENGINEER IN WRITING OF ANY DISCREPANCIES FOUND BETWEEN THE INTENDED FUNCTION OF EQUIPMENT AND EQUIPMENT SPECIFIED IN THE CONTRACT DOCUMENTS A MINIMUM OF FIVE (5) WORKING DAYS PRIOR TO ISSUANCE OF THE FINAL BID. FAILURE TO REPORT ANY DISCREPANCY (CATALOG NUMBERS, DISCONTINUED ITEMS, ETC.) DOES NOT RELIEVE THE CONTRACTOR FROM PROVIDING EQUIPMENT WHICH SHALL CONFORM TO AND FULFILL THE INTENT OF THE CONTRACT DOCUMENTS. NOR SHALL IT BE USED AS A CONDITION TO OBTAIN ADDITIONAL FUNDS FROM THE OWNER AFTER THE CONTRACT IS AWARDED. THE CONTRACTOR SHALL REQUEST ALL CLARIFICATIONS OF CONTRACT DOCUMENT REQUIREMENTS IN WRITING TO THE ARCHITECT/ENGINEER A MINIMUM OF FIVE (5) WORKING DAYS PRIOR TO ISSUANCE OF THE FINAL ADDENDUM.
- PROVIDE TYPED LABEL FOR ALL DUPLEX OUTLETS AND LIGHT SWITCHES TO INDICATE WHICH CIRCUIT THEY ARE TIED TO.
- INSTALL EXIT SIGNS ON THE WALL IF POSSIBLE.
- CONTRACT DOCUMENTS SHALL TAKE PRECEDENCE OVER SHOP DRAWINGS UNLESS SPECIFICALLY NOTED OTHERWISE.

ARCHITECTURE


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## MECHANICAL ENGINEER:

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WEBER STATE UNIVERSITY 3750 HARRISON BLVD. OGDEN UT 84408


## SOCIAL SCIENCE BUILDING 3RD FLOOR REMODEL


WSU: JIM HARRIS CAMPUS DEVELOPMENT 2601 UNIVERSITY CIRCLE OGDEN, UT 84408-2601

DFCM: TIM PARKINSON DFCM PROJECT #08319810

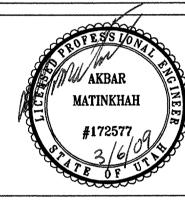MARCH 06, 2009 PROJECT NO: ECE 3552 CAD DWG FILE: DRAWN BY: PB CHECKED BY: AM

> SCHEDULES, DETAILS AND NOTES

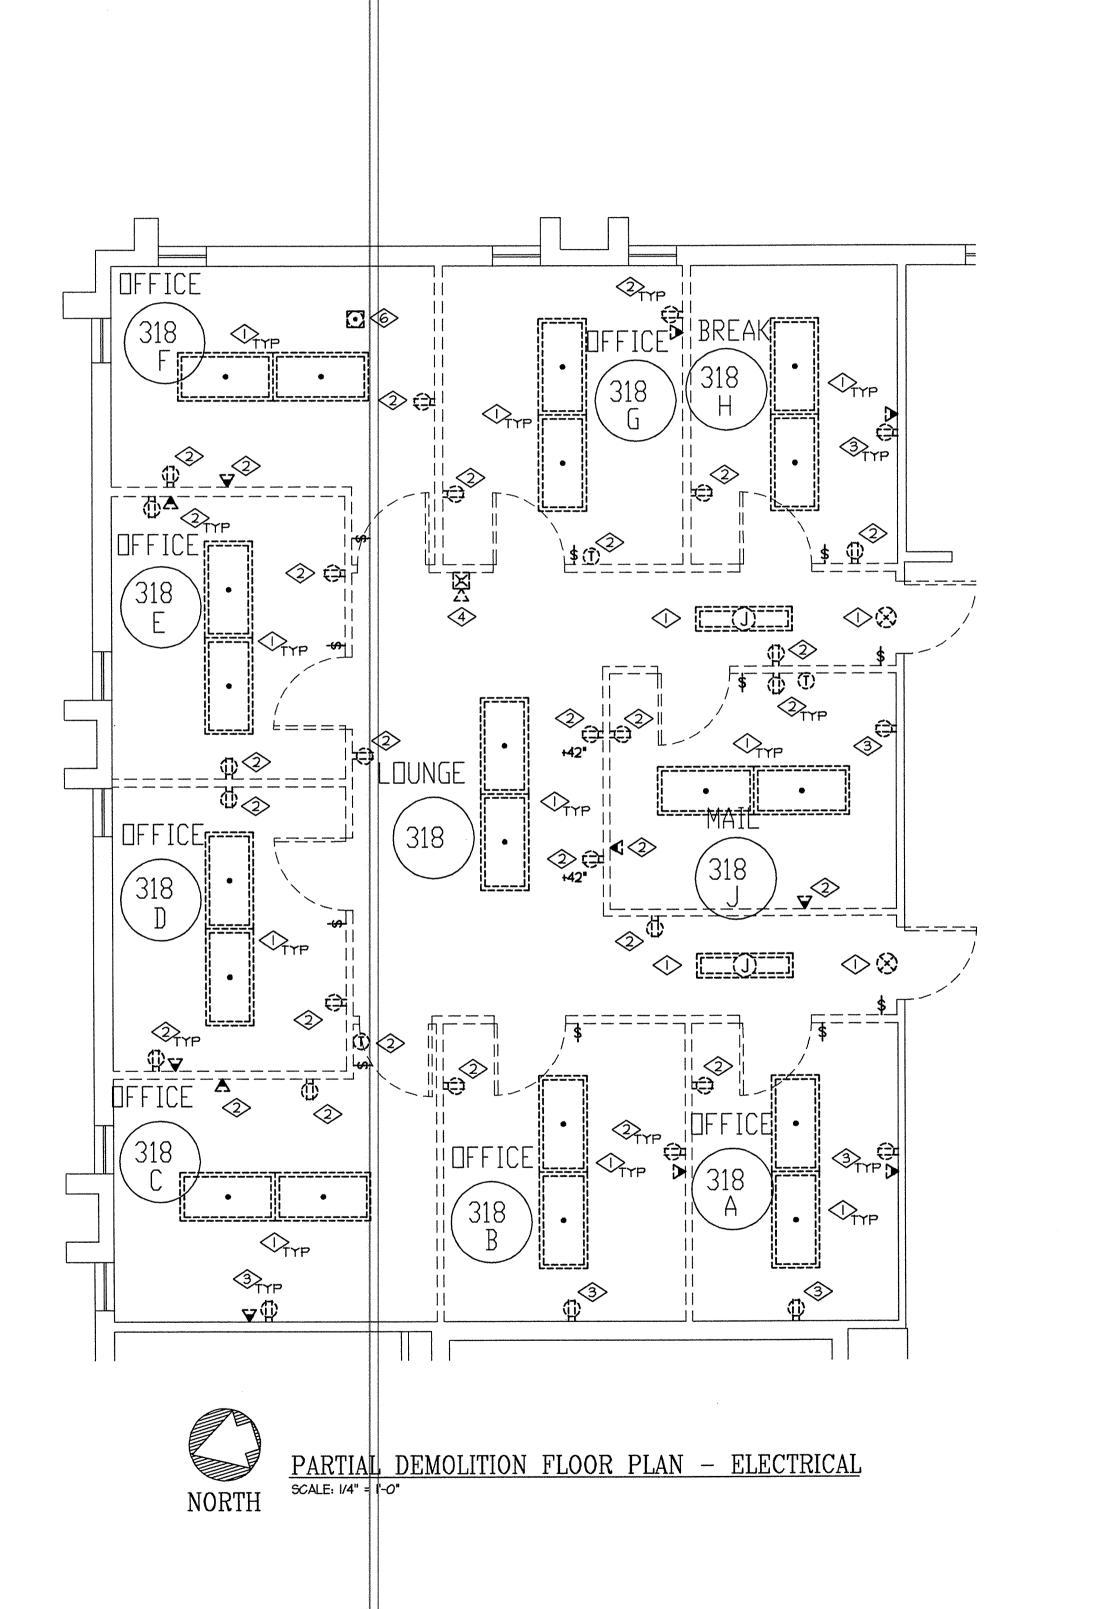

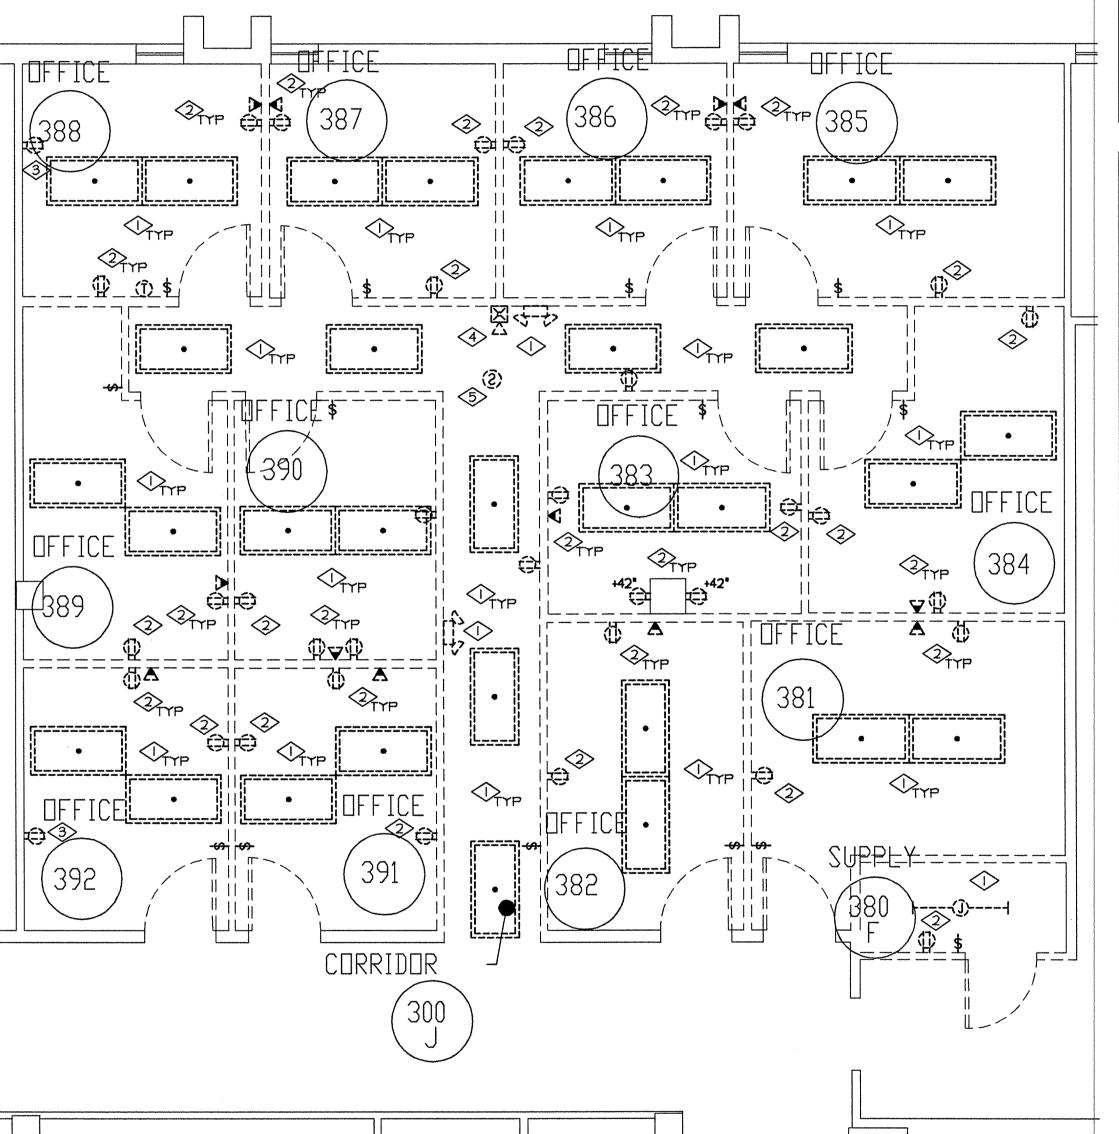

REFERENCE NOTES:

- EXISTING LIGHT FIXTURES ARE TO BE REMOVED. REMOVE CONDUIT, CONDUCTORS, ETC. ALL THE WAY BACK TO POINT OF ORIGINATION. REUSE EXISTING CIRCUIT AND CONDUITS AS POSSIBLE FOR NEW LIGHT FIXTURES. REMOVE ANY UNUSED CONDUCTORS, CONDUIT AND J-BOXES BACK TO ORIGINATION POINTS.
- EXISTING ELECTRICAL DEVICES ARE TO BE REMOVED FROM THE WALLS WHICH ARE BEING DEMOLISHED WHETHER OR NOT SHOWN ON THE DRAWING. REMOVE CONDUIT, CONDUCTORS, ETC. ALL THE WAY BACK TO POINT OF ORIGINATION. REUSE CONDUITS AS POSSIBLE FOR NEW DEVICES. PATCH EXISTING WALLS AND FLOORS AS REQUIRED TO MATCH ADJACENT SURFACES. COORDINATE THIS WORK WITH GENERAL CONTRACTOR. ALL VOICE AND DATA LINES ARE TO BE REMOVED BY WSU PERSONNEL SO AS TO AVOID SHORTING OR DAMAGING CATTPUS NETWORK EQUIPMENT.
- EXISTING ELECTRICAL DEVICES ARE TO REMAIN. REPLACE EXISTING DUPLEX OUTLETS, DATA OUTLETS AND COVERPLATES WITH NEW. TIE TO EXISTING CIRCUITS. MAKE ANY MODIFICATIONS REQUIRED TO MAINTAIN CIRCUIT INTEGRITY.
- REMOVE THE EXISTING FIRE ALARM DEVICES SHOWN. CLEAN AND RECALIBRATE DEVICES BEFORE REINSTALLATION. REINSTALL FIRE ALARM DEVICES IN THE APPROXIMATE LOCATIONS SHOWN ON SHEET E-IOI. EXTEND EXISTING CONDUIT TO NEW LOCATIONS. PROVIDE ADDITIONAL CONDUIT AND CONDUCTORS FOR A COMPLETE INSTALLATION. FIRE ALARM SYSTEM IS TO BE RECERTIFIED AFTER PROJECT COMPLETION.
- 5 EXISTING FIRE ALARM DEVICE IS TO BE REMOVED. REMOVE CONDUIT, CONDUCTORS, ETC. ALL THE WAY BACK TO POINT OF ORIGINATIONAL RETURN THE DEVICES TO WSU ELECTRICAL SHOP.
- REMOVE FLOOR OUTLET AND CONDUCTORS ALL THE WAY BACK TO ORIGINATION POINT. FURNISH AND INSTALL A BLANK PLATE TO COVER HOLE. PLATE TO BE FLUSH WITH FINISHED FLOOR.

## GENERAL DEMOLTION NOTES

I. UNDER DEMOLITION THE INTENT OF ELECTRICAL WORK IS TO REMOVE ALL ELECTRICAL DEVICES, LIGHT FIXTURES, CONDUIT, CONDUCTORS, J-BOXES, FIRE ALARM DEVICES, VOICE/DATA CABLING, VOICE/DATA OUTLETS, ETC. UNLESS INDICATED OTHERWISE. CONDUITS AND J-BOXES IN CONCRETE, MASONRY, AND BLOCK WALLS CAN BE LEFT IN THE WALLS AND REUSED FOR NEW DEVICES AS POSSIBLE. ALL ELECTRICAL DEVICES INCLUDING LIGHT FIXTURES, OUTLETS, ETC., WILL BE NEW. PROJECT AREA SHALL BE STRIPPED OF ALL MATERIALS.

- 2. ALL MATERIAL MUST BE REMOVED AND DISPOSED OF BY DEMOLITION CONTRACTOR, UNLESS INDICATED OTHERWISE ON DEMOLITION PLANS.
- 3. EXISTING DEMOLITION MATERIALS CAN NOT BE REUSED UNLESS INDICATED OTHERWISE.
- 4. ELECTRICAL CONTRACTOR IS TO PROVIDE TEMPORARY LIGHTING AND POWER FOR OTHER TRADES DURING DEMOLITION WORK.

  COORDINATE THIS WORK WITH THE GENERAL CONTRACTOR.
- 5. DEMOLITION CONTRACTOR IS TO REMOVE ALL ELECTRICAL CONNECTIONS AND CONTROL WIRING TO ALL THE EXISTING MECHANICAL EQUIPMENT IN THE REMODEL AREA, ETC. AS INDICATED. REMOVE ALL CONDUIT AND CONDUCTORS ALL THE WAY BACK TO PANELBOARDS. COORDINATE THIS WORK WITH MECHANICAL CONTRACTOR.
- T. PRIOR TO SUBMITTING A BID THE DEMOLITION CONTRACTOR SHALL INSPECT THE SITE AND INCLUDED IN HIS BID PACKAGE ALL CHARGES DUE TO EXISTING CONDITIONS.
- 8. ANY DAMAGE DONE TO EXISTING EQUIPMENT WHICH IS TO REMAIN WILL BE DEMOLITION CONTRACTOR RESPONSIBILITY TO REPLACE THEM WITH NEW ONES.

PANEL Q (120/208V)— (7 SPARE 20 AMP.)




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DATE: MARCH OG, 2009
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CAD DWG FILE:
DRAWN BY: PB

CHECKED BY: AM

DEMOLITION FLOOR PLAN - ELECTRICAL

ED-101

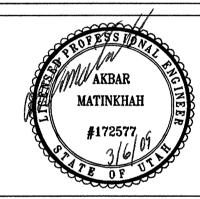

PARTIAL DEMOLITION FLOOR PLAN — ELECTRICAL SCALE: 1/4" = 1'-0"

(9 SPARE 20 AMP.)

KEY PLAN

